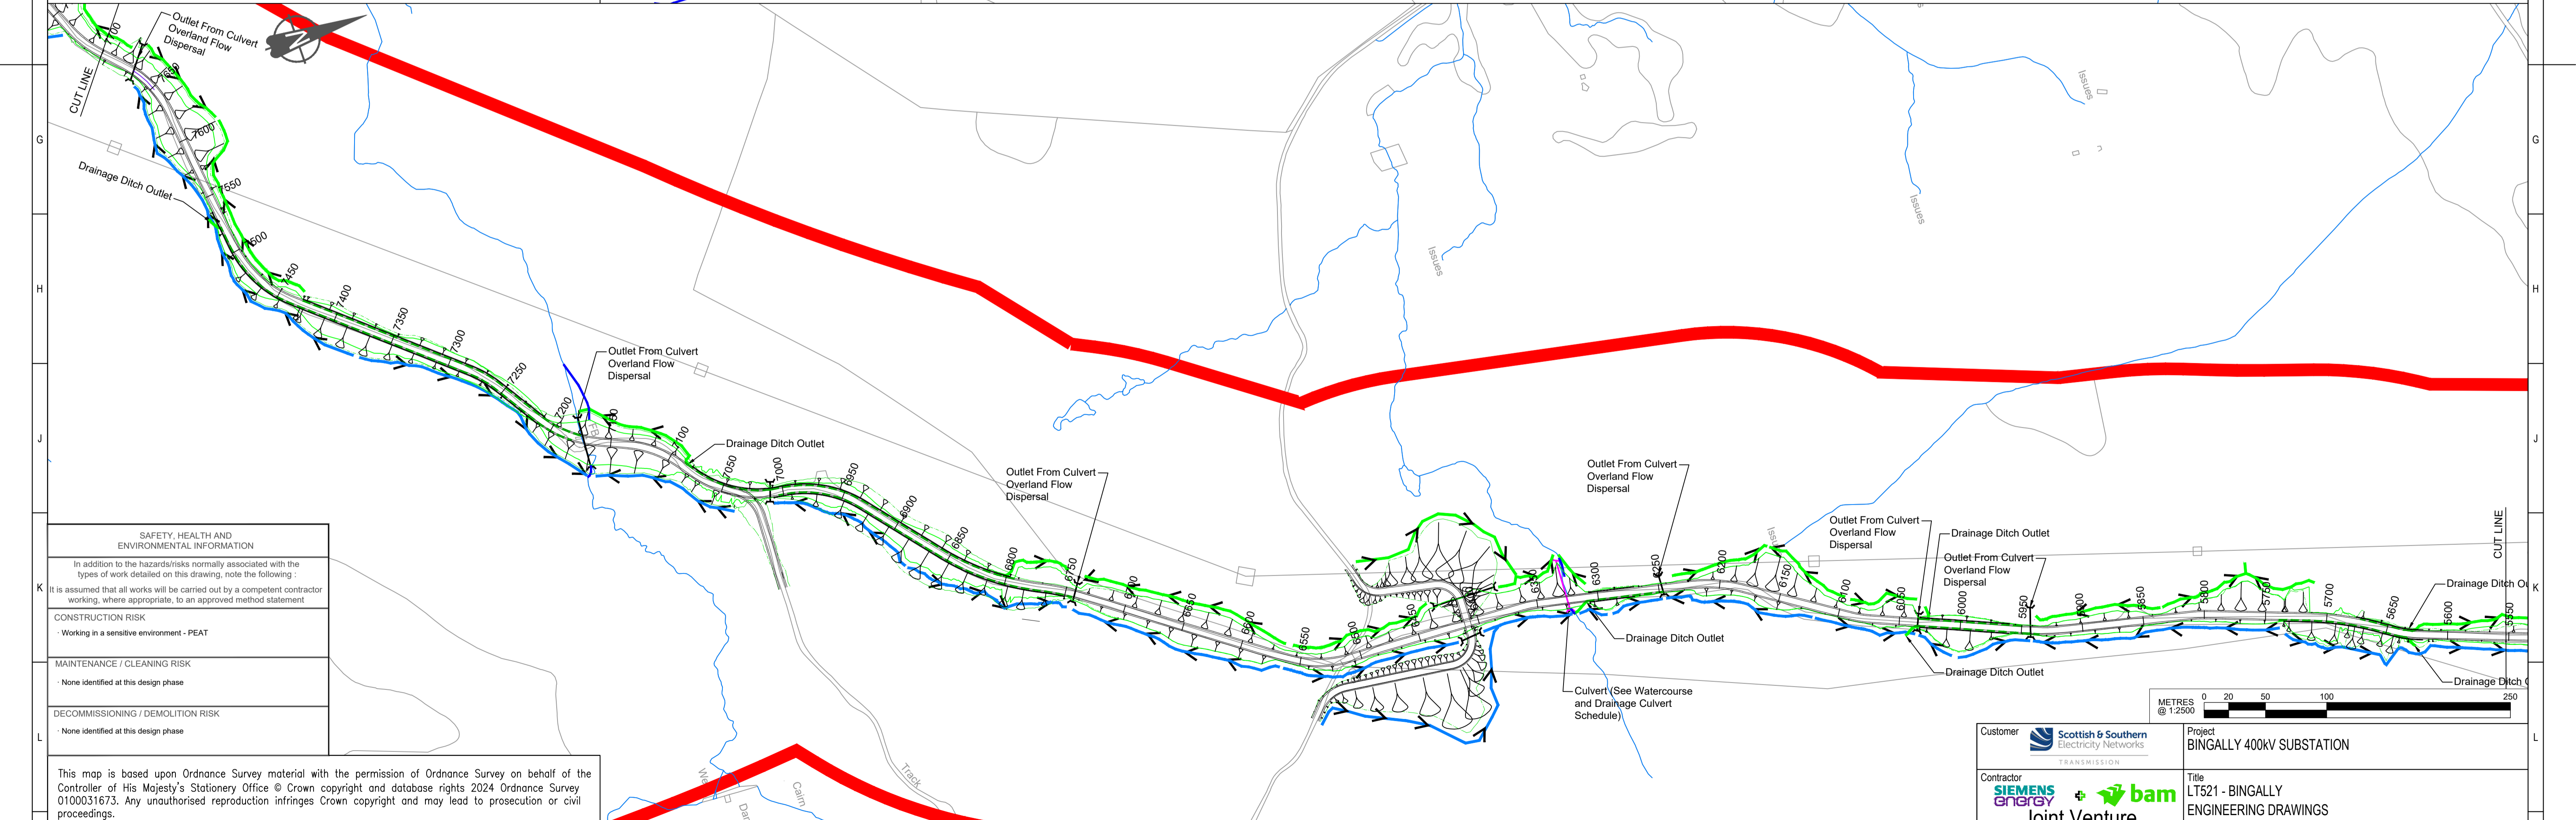


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SAFETY, HEALTH AND ENVIRONMENTAL INFORMATION	
In addition to the hazards/risks normally associated with the types of work detailed on this drawing, note the following:	
It is assumed that all works will be carried out by a competent contractor working, where appropriate, to an approved method statement.	
CONSTRUCTION RISK	
Working in a sensitive environment - PEAT	
MAINTENANCE / CLEANING RISK	
None identified at this design phase	
DECOMMISSIONING / DEMOLITION RISK	
None identified at this design phase	

DRAWING STATUS: ISSUED FOR REVIEW	REVISION:	P01.1
	DRAWN:	J.PETRIE 03/09/2024
	CHECKED:	R.DUNCAN 03/09/2024
	APPROVED:	R.MINTO 03/09/2024
PROJECT REF:		BING4-LT521
FIRST ISSUE:		04/09/2024

- NOTES
- DITCH DIMENSIONS ARE PRELIMINARY ONLY AND TO BE FINALISED AT DETAILED DESIGN UPON COORDINATION WITH EARTHWORKS AND CULVERT DESIGNS.
  - DITCH SIZES REFER TO CAPACITY REQUIREMENTS ONLY. ADDITIONAL CUT AND FILL MAY BE REQUIRED TO GRADE EXISTING GROUND.
  - SETTLEMENT LAGOON EXTENTS SHOWN TO NOT INCLUDE EARTHWORKS EXTENTS.
  - DURING CONSTRUCTION PARTICULAR CARE IS TO BE TAKEN BY THE CONTRACTOR TO ENSURE THAT THE MINIMUM AMOUNT OF DAMAGE AND DISTURBANCE TO LAND DRAINS AND DITCHES ARE CAUSED. THE CONTRACTOR WILL INVESTIGATE, DESIGN, INSTALL, REPAIR AND MAINTAIN ALL LAND DRAINS THAT ARE AFFECTED BY THE WORKS AS PER THE CIVIL SCOPE OF WORKS.
  - COORDINATION OF DRAINAGE DESIGN AND CABLE COORDINATES TO BE CONFIRMED.

**LEGEND:**

- TYPE A OR TYPE B HIGHSIDE DITCH AS INDICATED ON ACCOMPANYING SPREADSHEET
- SWALE
- DRAINAGE DITCH (PERMANENT TRACK)
- DRAINAGE CULVERT
- WATERCOURSE CULVERT
- SUSTAINABLE URBAN DRAINAGE SYSTEM
- WATERCOURSE REALIGNMENT



Customer <b>Scottish &amp; Southern Electricity Networks</b>	Project <b>BINGALLY 400KV SUBSTATION</b>
Contractor <b>SIEMENS energy + bam</b> <b>Joint Venture</b> <b>Substation Delivery Framework</b>	Title <b>LT521 - BINGALLY</b> <b>ENGINEERING DRAWINGS</b> <b>PROPOSED TRACK DRAINAGE LAYOUT SHEET 1</b>
Subcon. Drawing No. <b>FAIRHURST</b>	Contractor Drawing No. <b>BING4-LT521-SEBAM-DRAI-ZZ-D-C-0191</b>
BING4-LT521-SEBAM-DRAI-ZZ-D-C-0191	Customer Drawing No. <b>BING4-LT521-SEBAM-DRAI-ZZ-D-C-0191</b>
Designed J.PETRIE	Drawn S.MITCHELL
Checked J.PETRIE	Approved R.MINTO
Date 03/09/2024	Scale 1:2500
Size A1	Sheet 1 of 1
Revision 1	Sheet P01.1