

ELEVATION KEY:



- ① SINGLE PLY MEMBERS ON FLAT INSULATED METAL PANEL - RAL 6007 BOTTLE GREEN (TBC)
- ② INSULATED METAL WALL CLADDING PANEL - RAL 6007 BOTTLE GREEN (TBC)
- ③ METAL DOOR - RAL 6007 BOTTLE GREEN (TBC)
- ④ ALUMINIUM PPC BOX GUTTER - RAL TBC
- ⑤ ALUMINIUM PPC SQUARE RAINWATER DOWNPIPE (ANTI-CLIMB) - RAL TBC
- ⑥ ALUMINIUM PPC SNOW GUARD ABOVE DOOR - RAL TBC
- ⑦ METAL LOUVRE - RAL TBC

NOTE: MATERIALS WILL BE AS DESCRIBED ABOVE. VISUAL REPRESENTATIONS OF MATERIAL COLOURS MAY DIFFER SLIGHTLY ON PDF AND PRINT COPIES OF DRAWINGS.

NOTES:


- 1. THIS DRAWING IS FOR PLANNING PURPOSES ONLY SUBJECT TO DETAILED DESIGN.
- 2. DO NOT SCALE FROM THIS DRAWING. USE ONLY SPECIFIED DIMENSIONS.
- 3. ALL DIMENSIONS ARE IN MILLIMETRES UNLESS NOTED OTHERWISE.
- 4. ALL LEVELS ARE IN METRES TO ORDNANCE DATUM UNLESS NOTED OTHERWISE.
- 5. CONTROL BUILDING SHALL BE DESIGNED AND DETAILED IN ACCORDANCE WITH SP-NET-CIV- Rev1.00.

LEGEND:

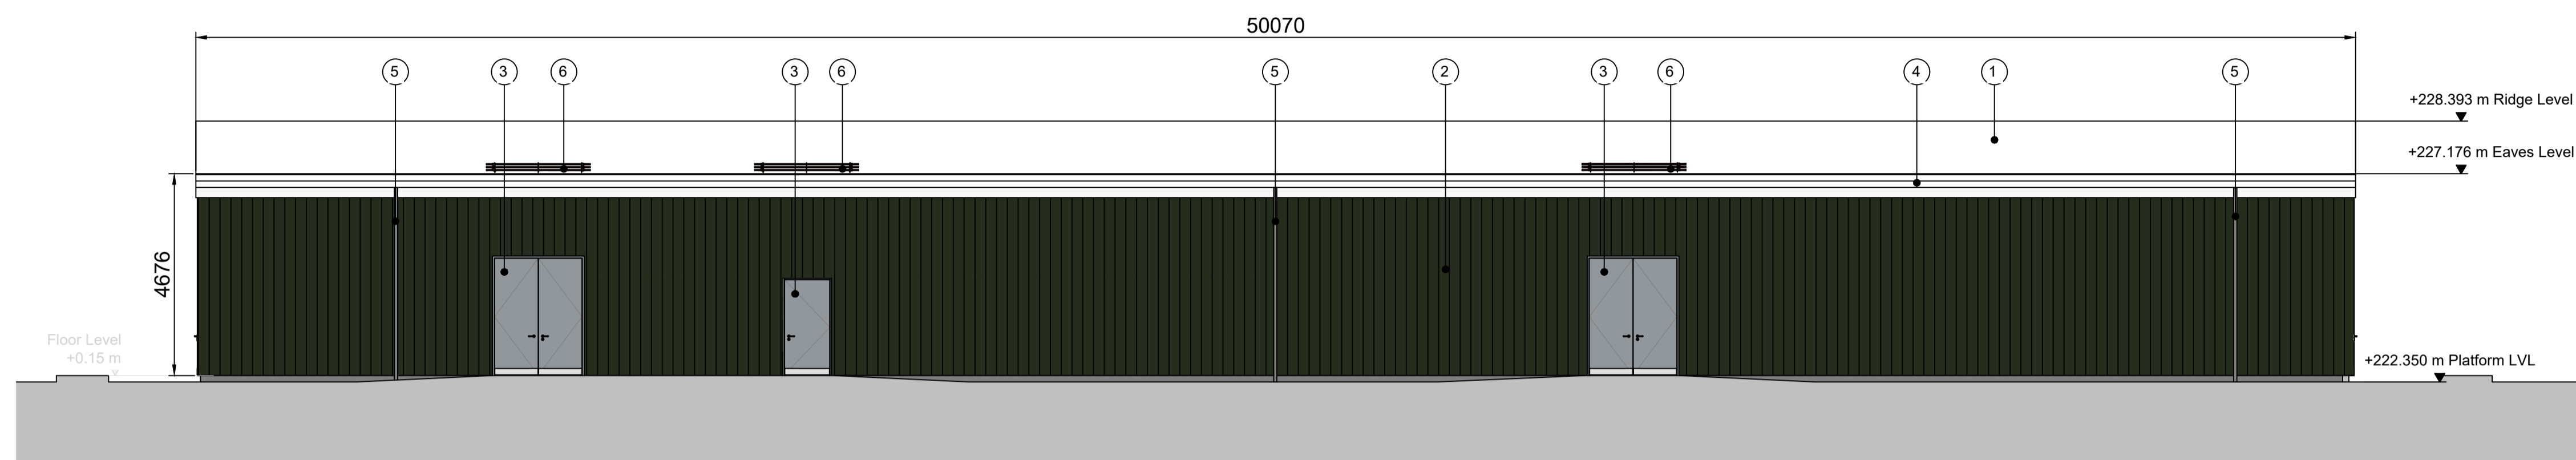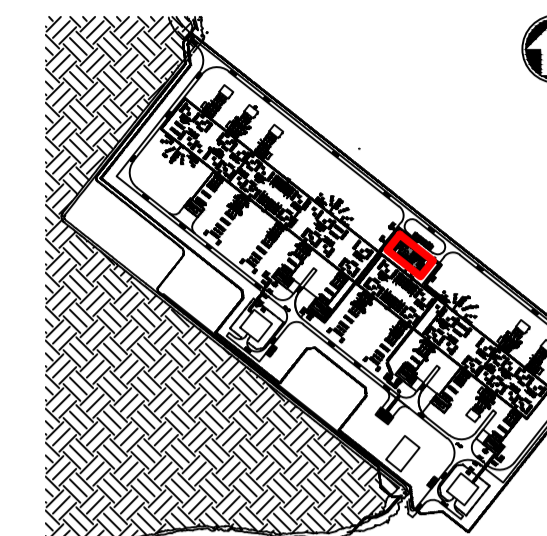


South West Elevation Control Building

Scale 1:100

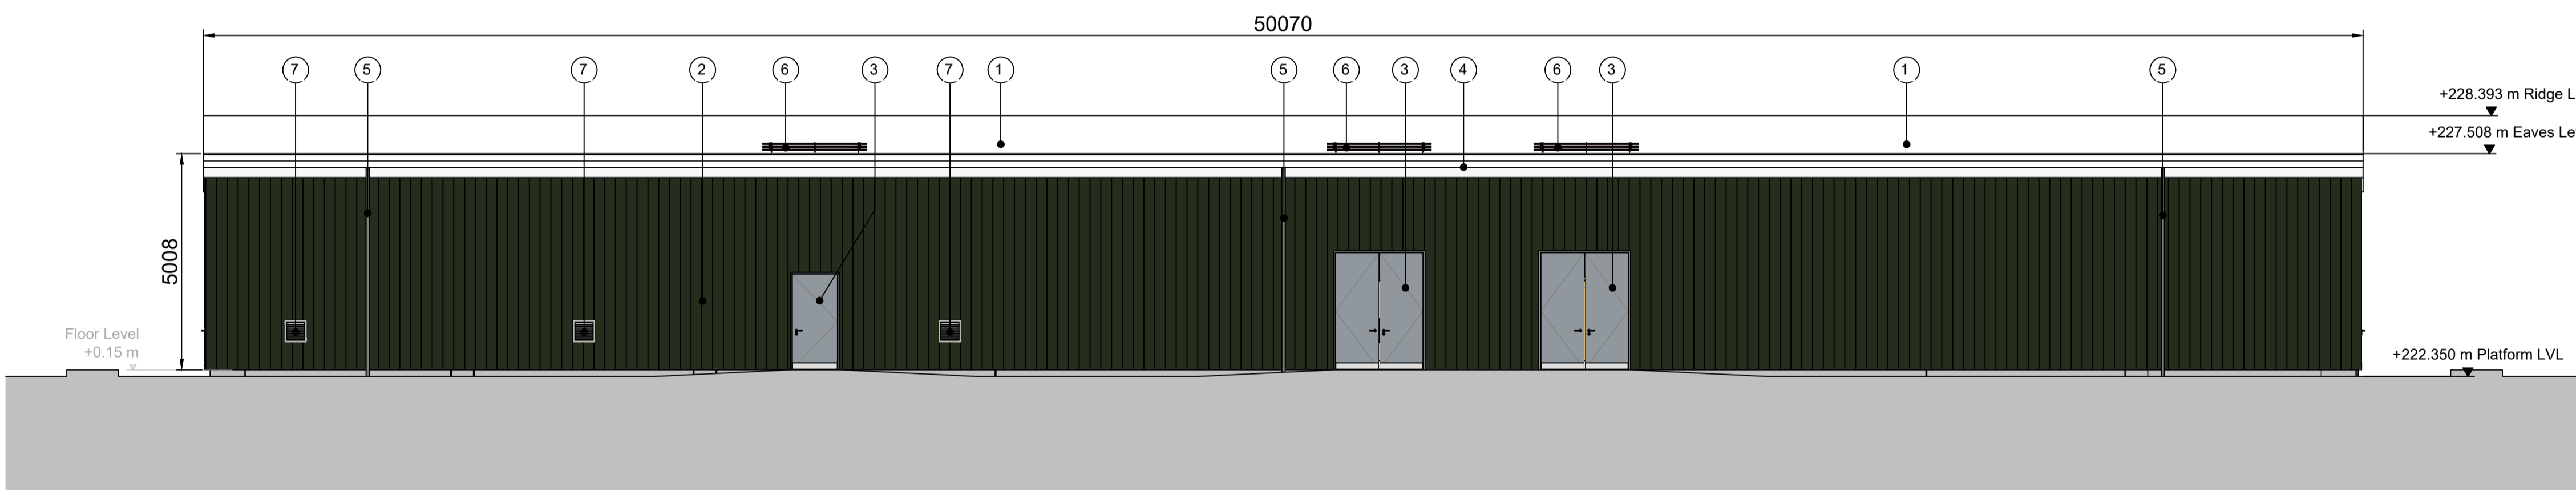


North East Elevation Control Building

Scale 1:100

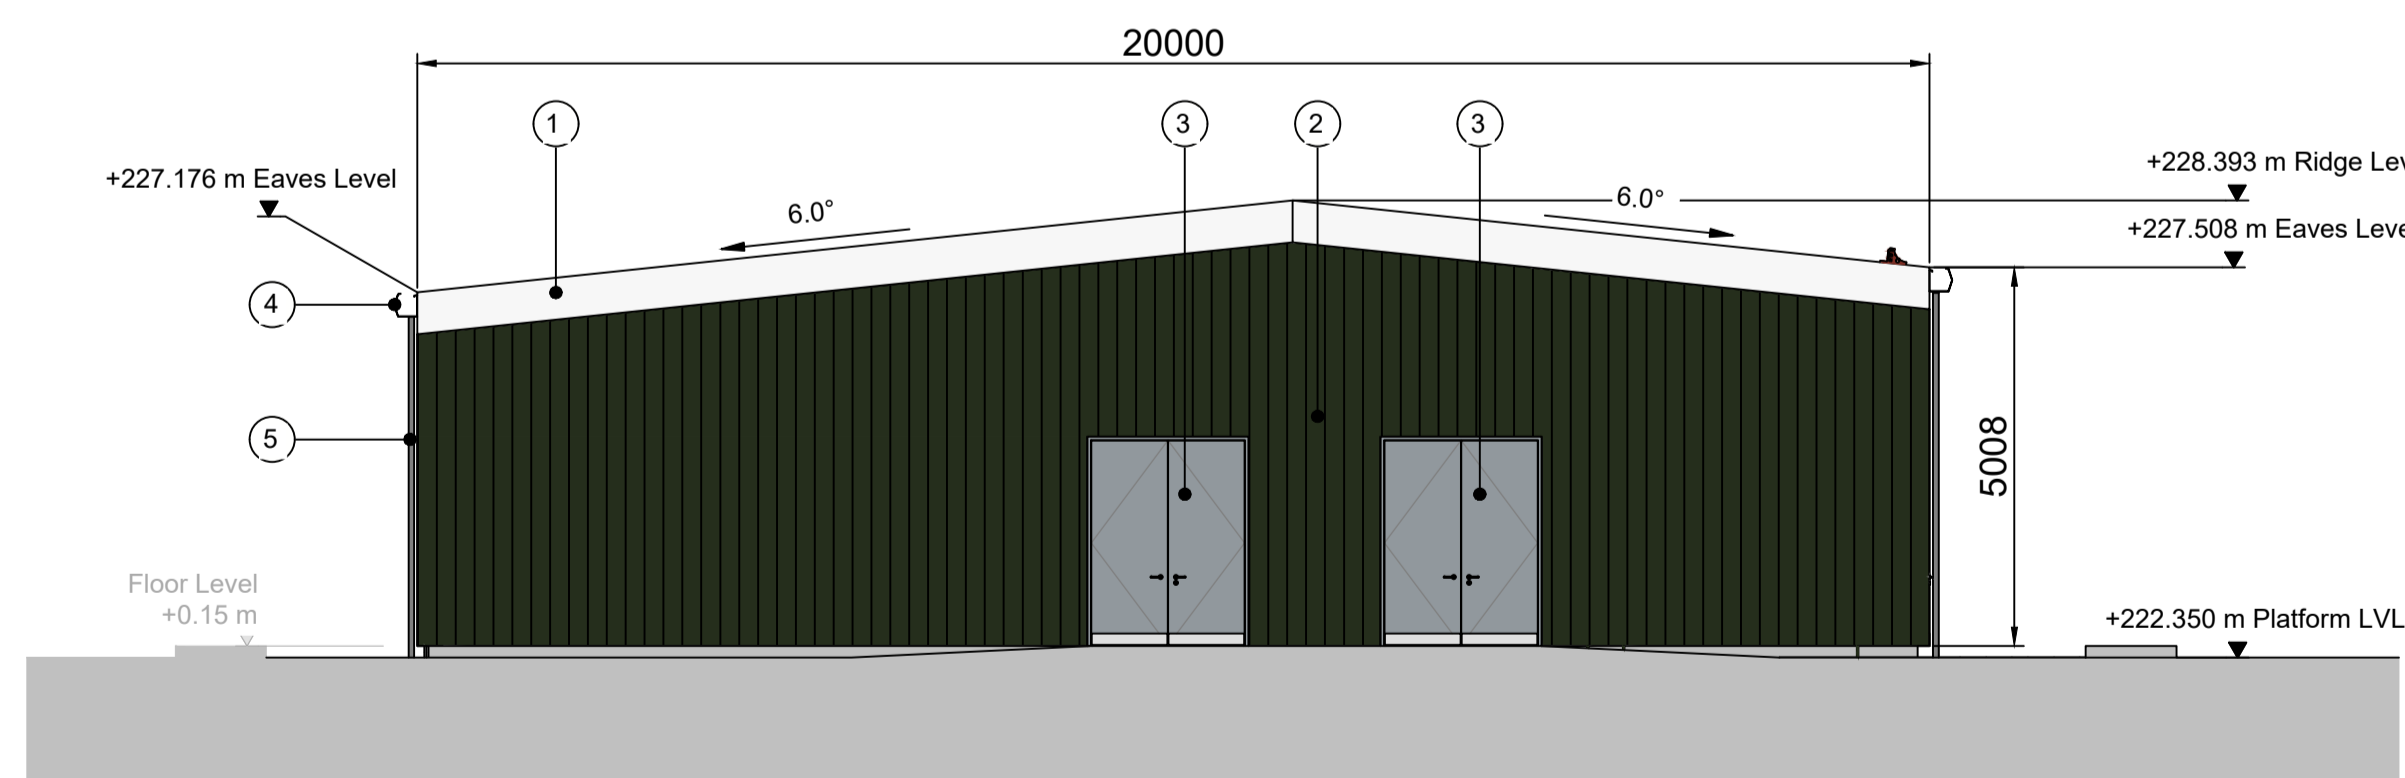


South East Elevation Control Building

Scale 1:100

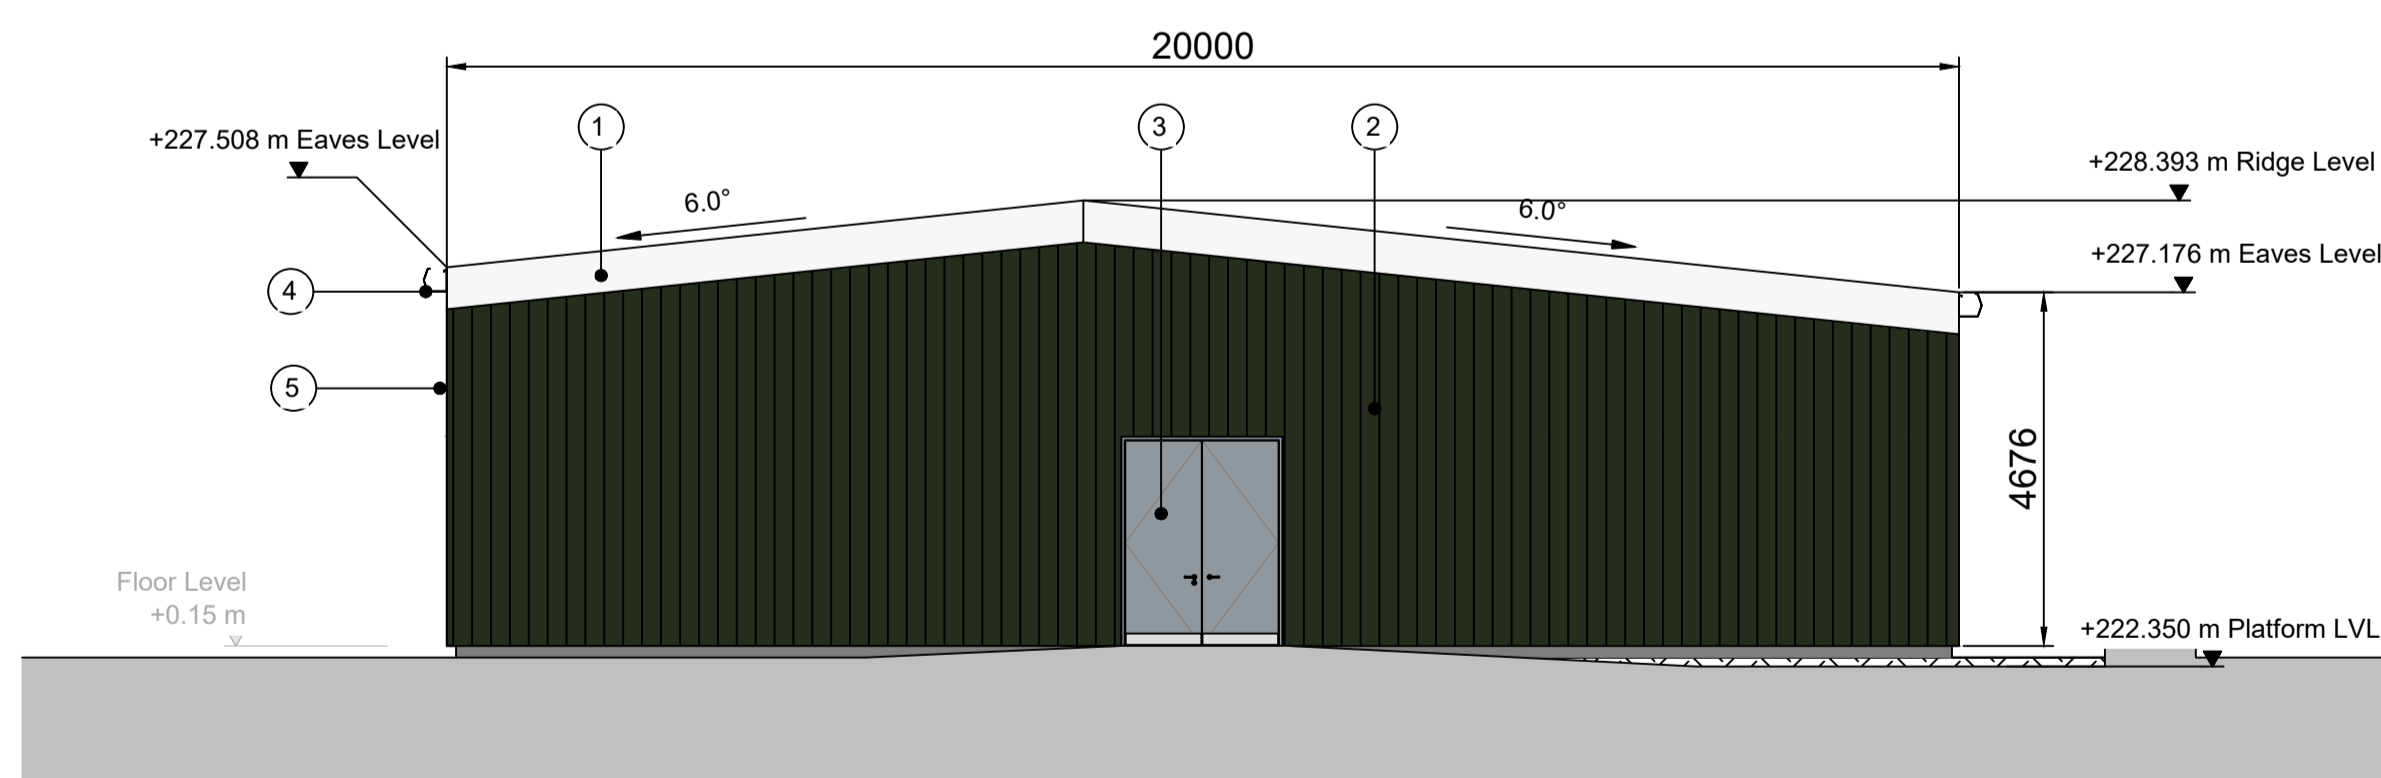

North West Elevation Control Building

Scale 1:100

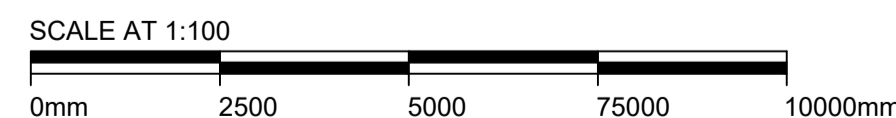

Issue / Revision:	01	Drawn By:	BSM	Issue / Revision:	02	Drawn By:	BSM
Investment No.:	N/A	Checked By:	JF	Investment No.:	N/A	Checked By:	JF
Date:	27/SEP/24	Approved By:	RC	Date:	12/NOV/24	Approved By:	RC
Description / Remarks				Description / Remarks			
ISSUED FOR PLANNING				ISSUED FOR PLANNING			

Drawing Status:			
ISSUED FOR PLANNING			
Software:	Status Code:	Scale:	Paper Size:
AUTOCAD	Not Used	1:100	A1
Drawn By:	Checked By:	Approved By:	Date:
BSM	JF	RC	27/SEP/24
Contractor:			
BURNS & McDONNELL			
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Client:		Supplier / Subcontractor:	
Drawing Title:			
CONTROL BUILDING ELEVATIONS			
Project Name:			
HURLIE 400kV SUBSTATION			
Site Name:			
HURLIE 400kV SUBSTATION			
Contractor Drawing No.:			
162507-BMD-BL-HR-DEL-TP-0001			
Client Drawing No.:		Sheet: 1 OF 1	
162507-BMD-BL-HR-DEL-TP-0001		Next: -	
Supplier / Subcontractor Drawing No.:		Issue / Revision:	
XXX		02	
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