

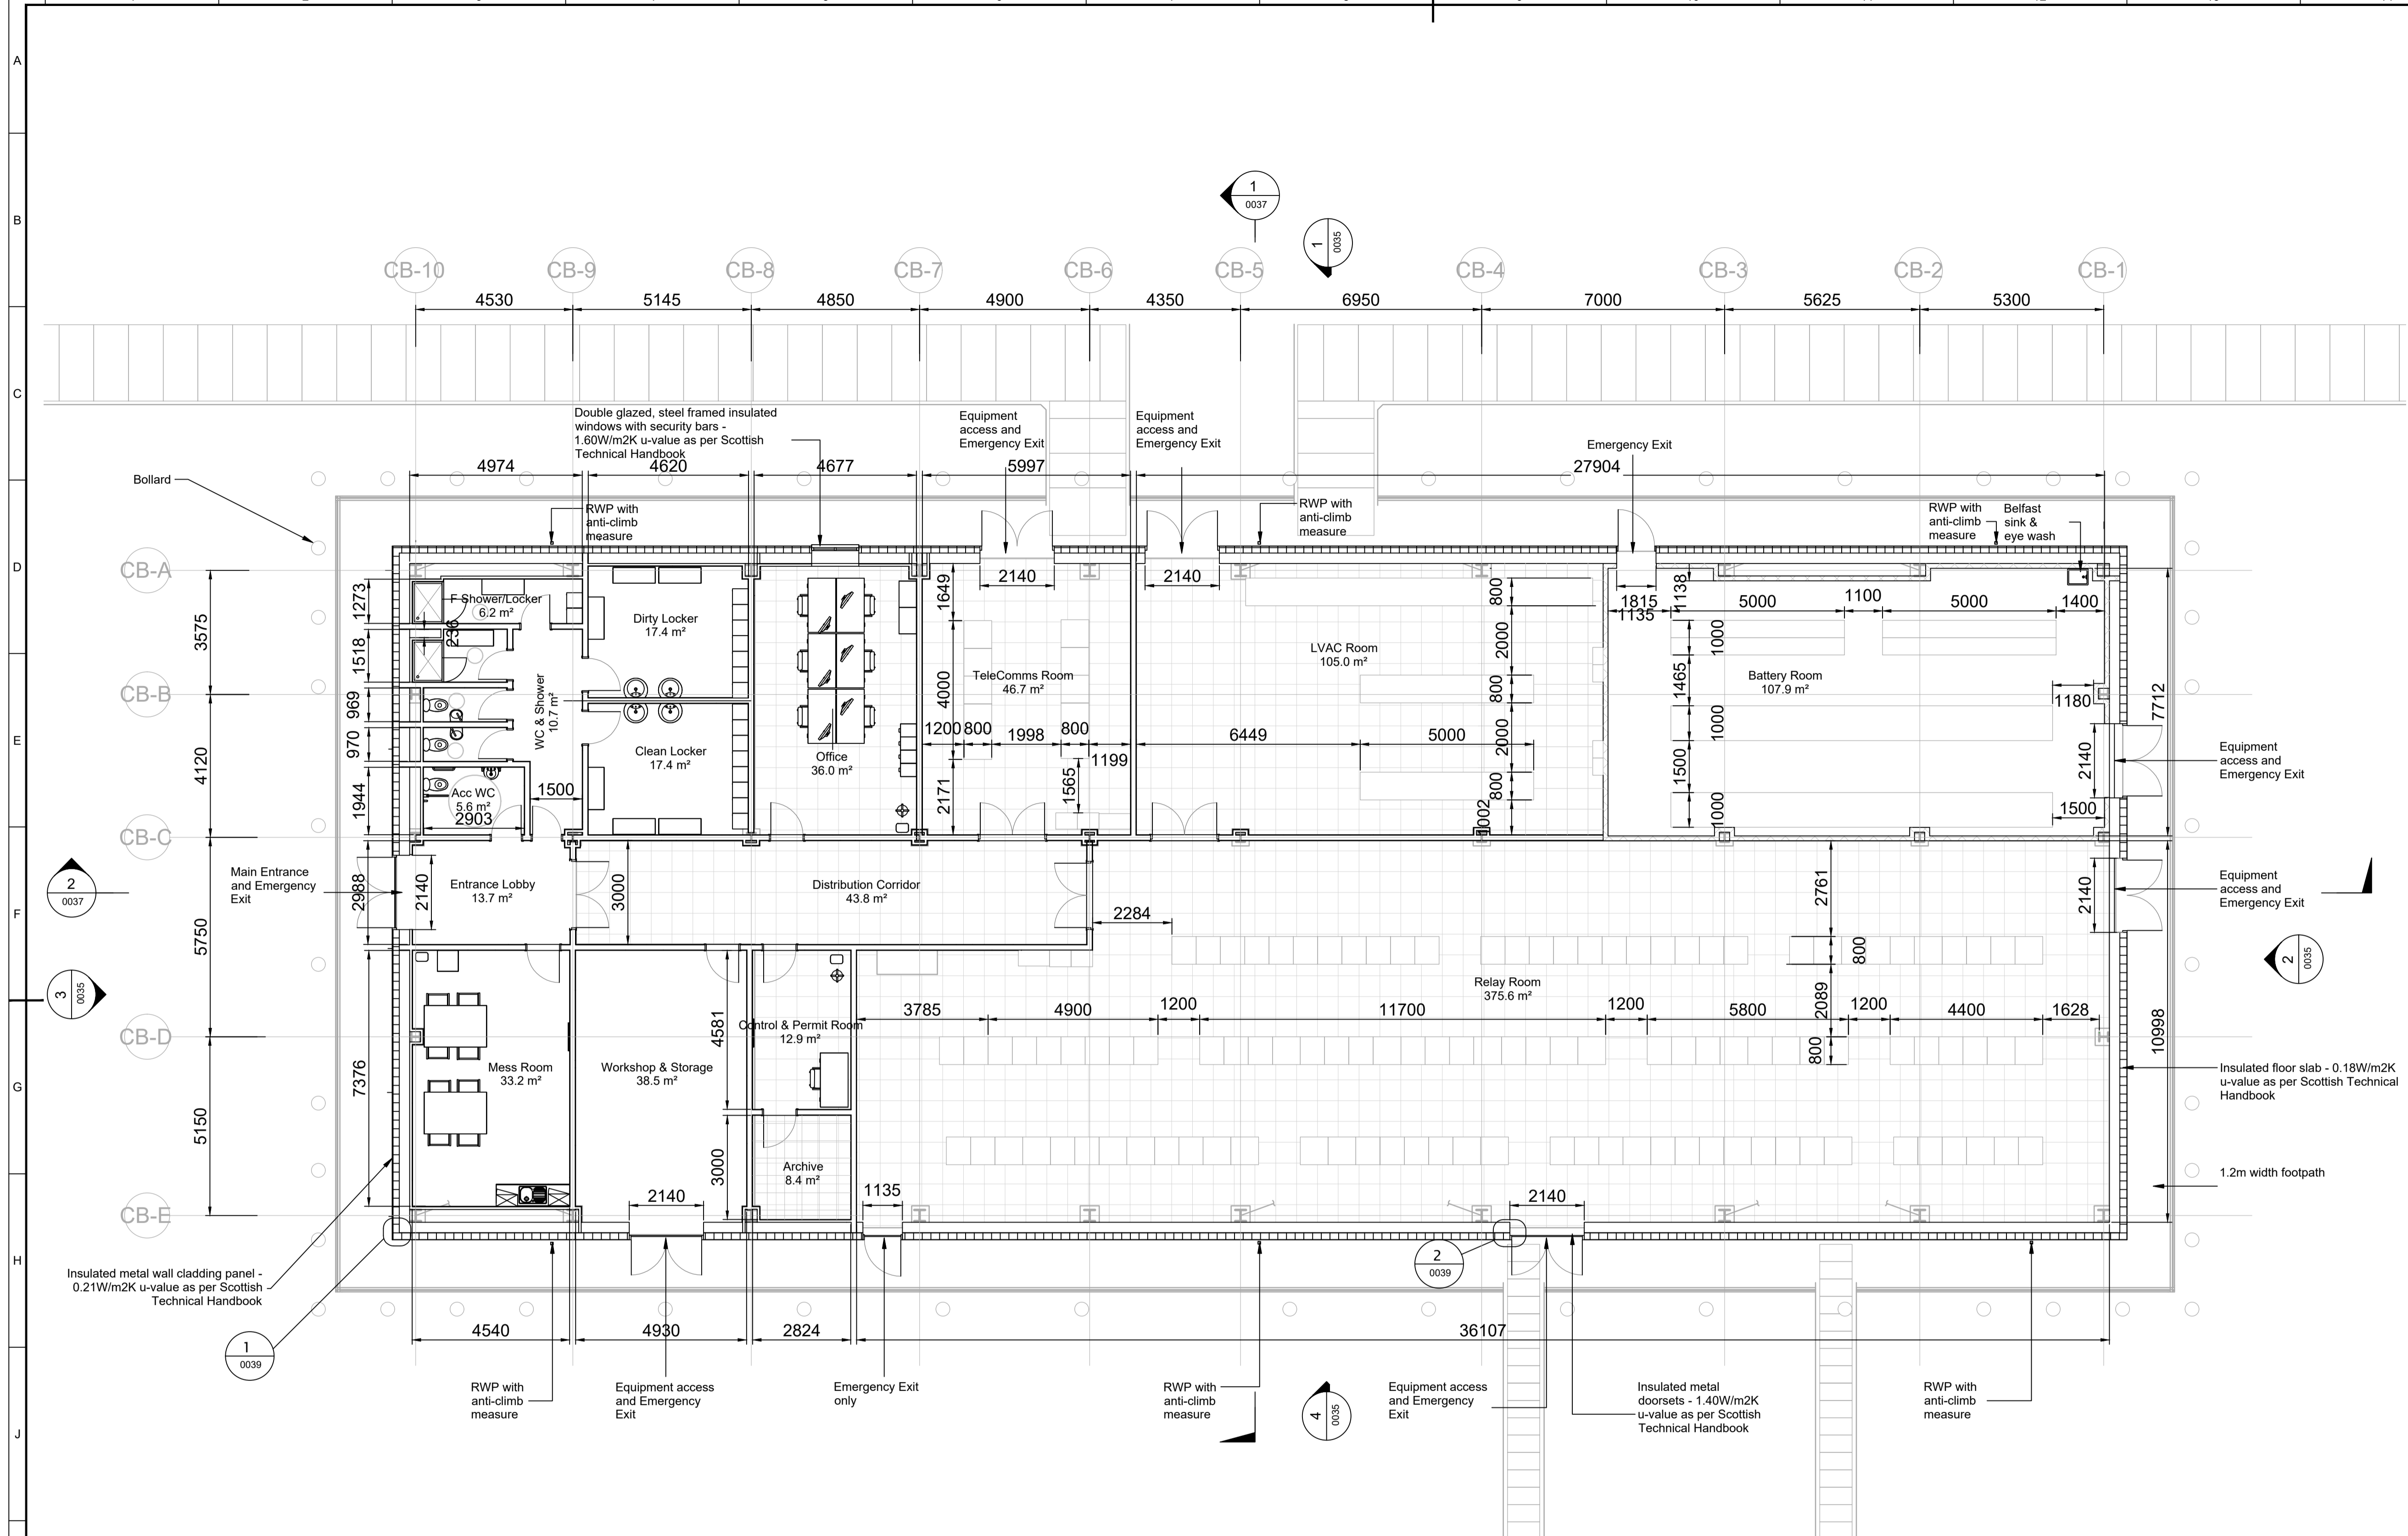


- NOTES:**
- THIS DRAWING IS FOR PLANNING PURPOSES ONLY SUBJECT TO DETAILED DESIGN.
  - DO NOT SCALE FROM THIS DRAWING. USE ONLY SPECIFIED DIMENSIONS.
  - ALL DIMENSIONS ARE IN MILLIMETRES UNLESS NOTED OTHERWISE.
  - ALL LEVELS ARE IN METRES TO ORDNANCE DATUM UNLESS NOTED OTHERWISE.
  - CONTROL BUILDING SHALL BE DESIGNED AND DETAILED IN ACCORDANCE WITH SP-NET-CIV- Rev1.00.

**LEGEND:**

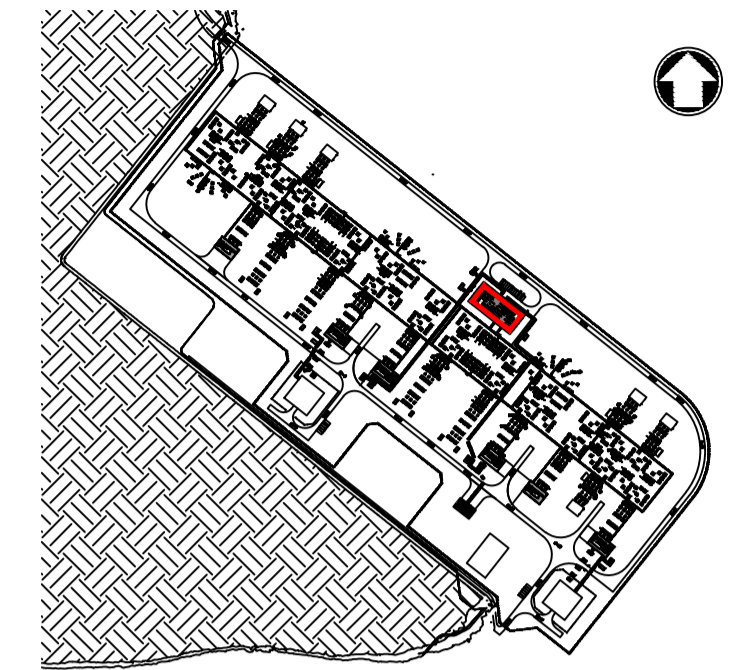

**Control Building Floor Plan**  
Scale 1:100

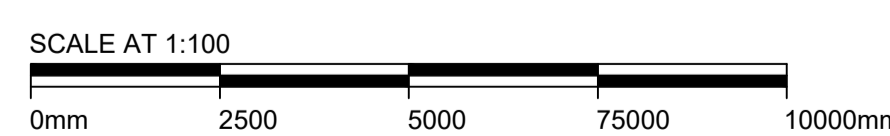

Issue / Revision:	01	Drawn By:	RB
Investment No.:	N/A	Checked By:	JF
Date:	15/NOV/24	Approved By:	RC

Description / Remarks  
ISSUED FOR PLANNING

<b>Drawing Status:</b> ISSUED FOR PLANNING			
Software: AUTOCAD	Status Code: Not Used	Scale: 1:100	Paper Size: A1
Drawn By: RB	Checked By: JF	Approved By: RC	Date: 15/NOV/24
<b>Contractor:</b> <b>BURNS MCDONNELL</b> <small>Burns &amp; McDonnell Europe (UK) Limited, trading as Burns &amp; McDonnell Controlbook, 2 Cornhill Street, Birmingham, B3 2ZA, UK Email: info@burnsrod.com Website: www.burnsmcd.com</small>			
<b>Client:</b> <b>Scottish &amp; Southern</b> <small>Electricity Networks</small>		<b>Supplier / Subcontractor:</b>	
<b>Drawing Title:</b> CONTROL BUILDING FLOOR PLAN			
<b>Project Name:</b> HURLIE 400KV SUBSTATION			
<b>Site Name:</b> HURLIE 400KV SUBSTATION			
<b>Contractor Drawing No.:</b> 162507_BMD-BL-HR-DEL-TP-0004			
<b>Client Drawing No.:</b> 162507_BMD-BL-HR-DEL-TP-0004		<b>Sheet:</b> 1 OF 1	
<b>Supplier / Subcontractor Drawing No.:</b> XXX		<b>Next:</b> -	
		<b>Issue / Revision:</b> 01	

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