


ELEVATION A-A
SCALE 1:500

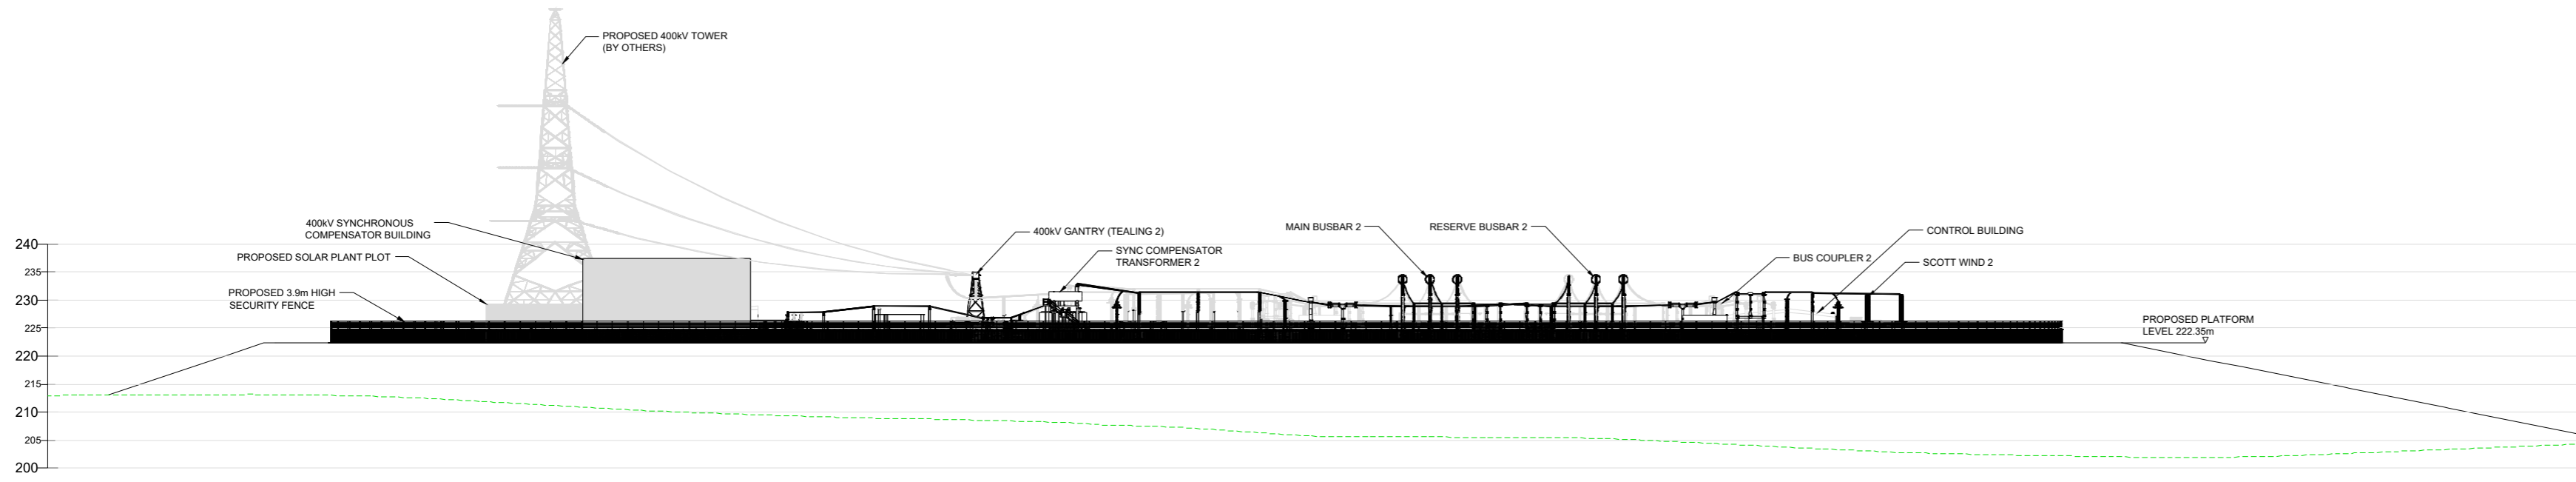


ELEVATION B-B
SCALE 1:500


NOTES:
 1. DO NOT SCALE FROM THIS DRAWING. USE ONLY SPECIFIED DIMENSIONS.
 2. ALL LEVELS ARE IN METRES TO ORDNANCE DATUM UNLESS NOTED OTHERWISE.

REFERENCE DRAWINGS:
 162507-BMD-CE-HR-DSE-TP-0001 PLATFORM EARTHWORKS LAYOUT
 162507-BMD-PL-HR-DPL-TP-0001 ELECTRICAL LAYOUT

LEGEND:
 --- EXISTING TERRAIN

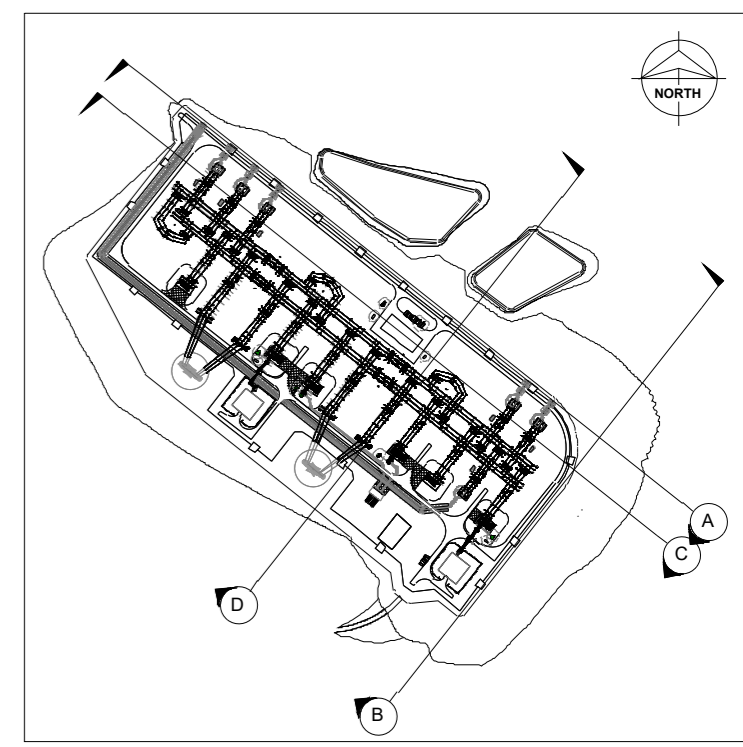

KEY PLAN
SCALE 1:5000

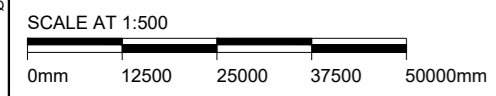

Issue / Revision:	P01	Drawn By:	CN
Investment No.:		Checked By:	RC
Date:	21/NOV/24	Approved By:	PM

Description / Remarks
ISSUED FOR PLANNING

Drawing Status: FOR PLANNING			
Software: AUTOCAD	Status Code: Not Used	Scale: 1:500	Paper Size: A0
Drawn By: CN	Checked By: RC	Approved By: PM	Date: 21/NOV/24
Contractor: BURNS & MCDONNELL <small>Burns & McDonnell Europe (UK) Limited, trading as Burns & McDonnell, 2 Parklands Way, Macc Park, Metherall, ML1 4WR, UK. Email: bmd@burns-mcd.com Website: www.burnsmcd.com</small>			
Client: Scottish & Southern Electricity Networks		Supplier / Subcontractor:	
Drawing Title: SITE ELEVATIONS			
Project Name: HURLIE 400kV SUBSTATION			
Site Name: HURLIE 400kV SUBSTATION			
Contractor Drawing No.: 162507-BMD-CE-HR-DEL-TP-0003			
Client Drawing No.: 162507-BMD-CE-HR-DEL-TP-0003		Sheet: 01	Next: 02
Supplier / Subcontractor Drawing No.:		Issue / Revision: P01	