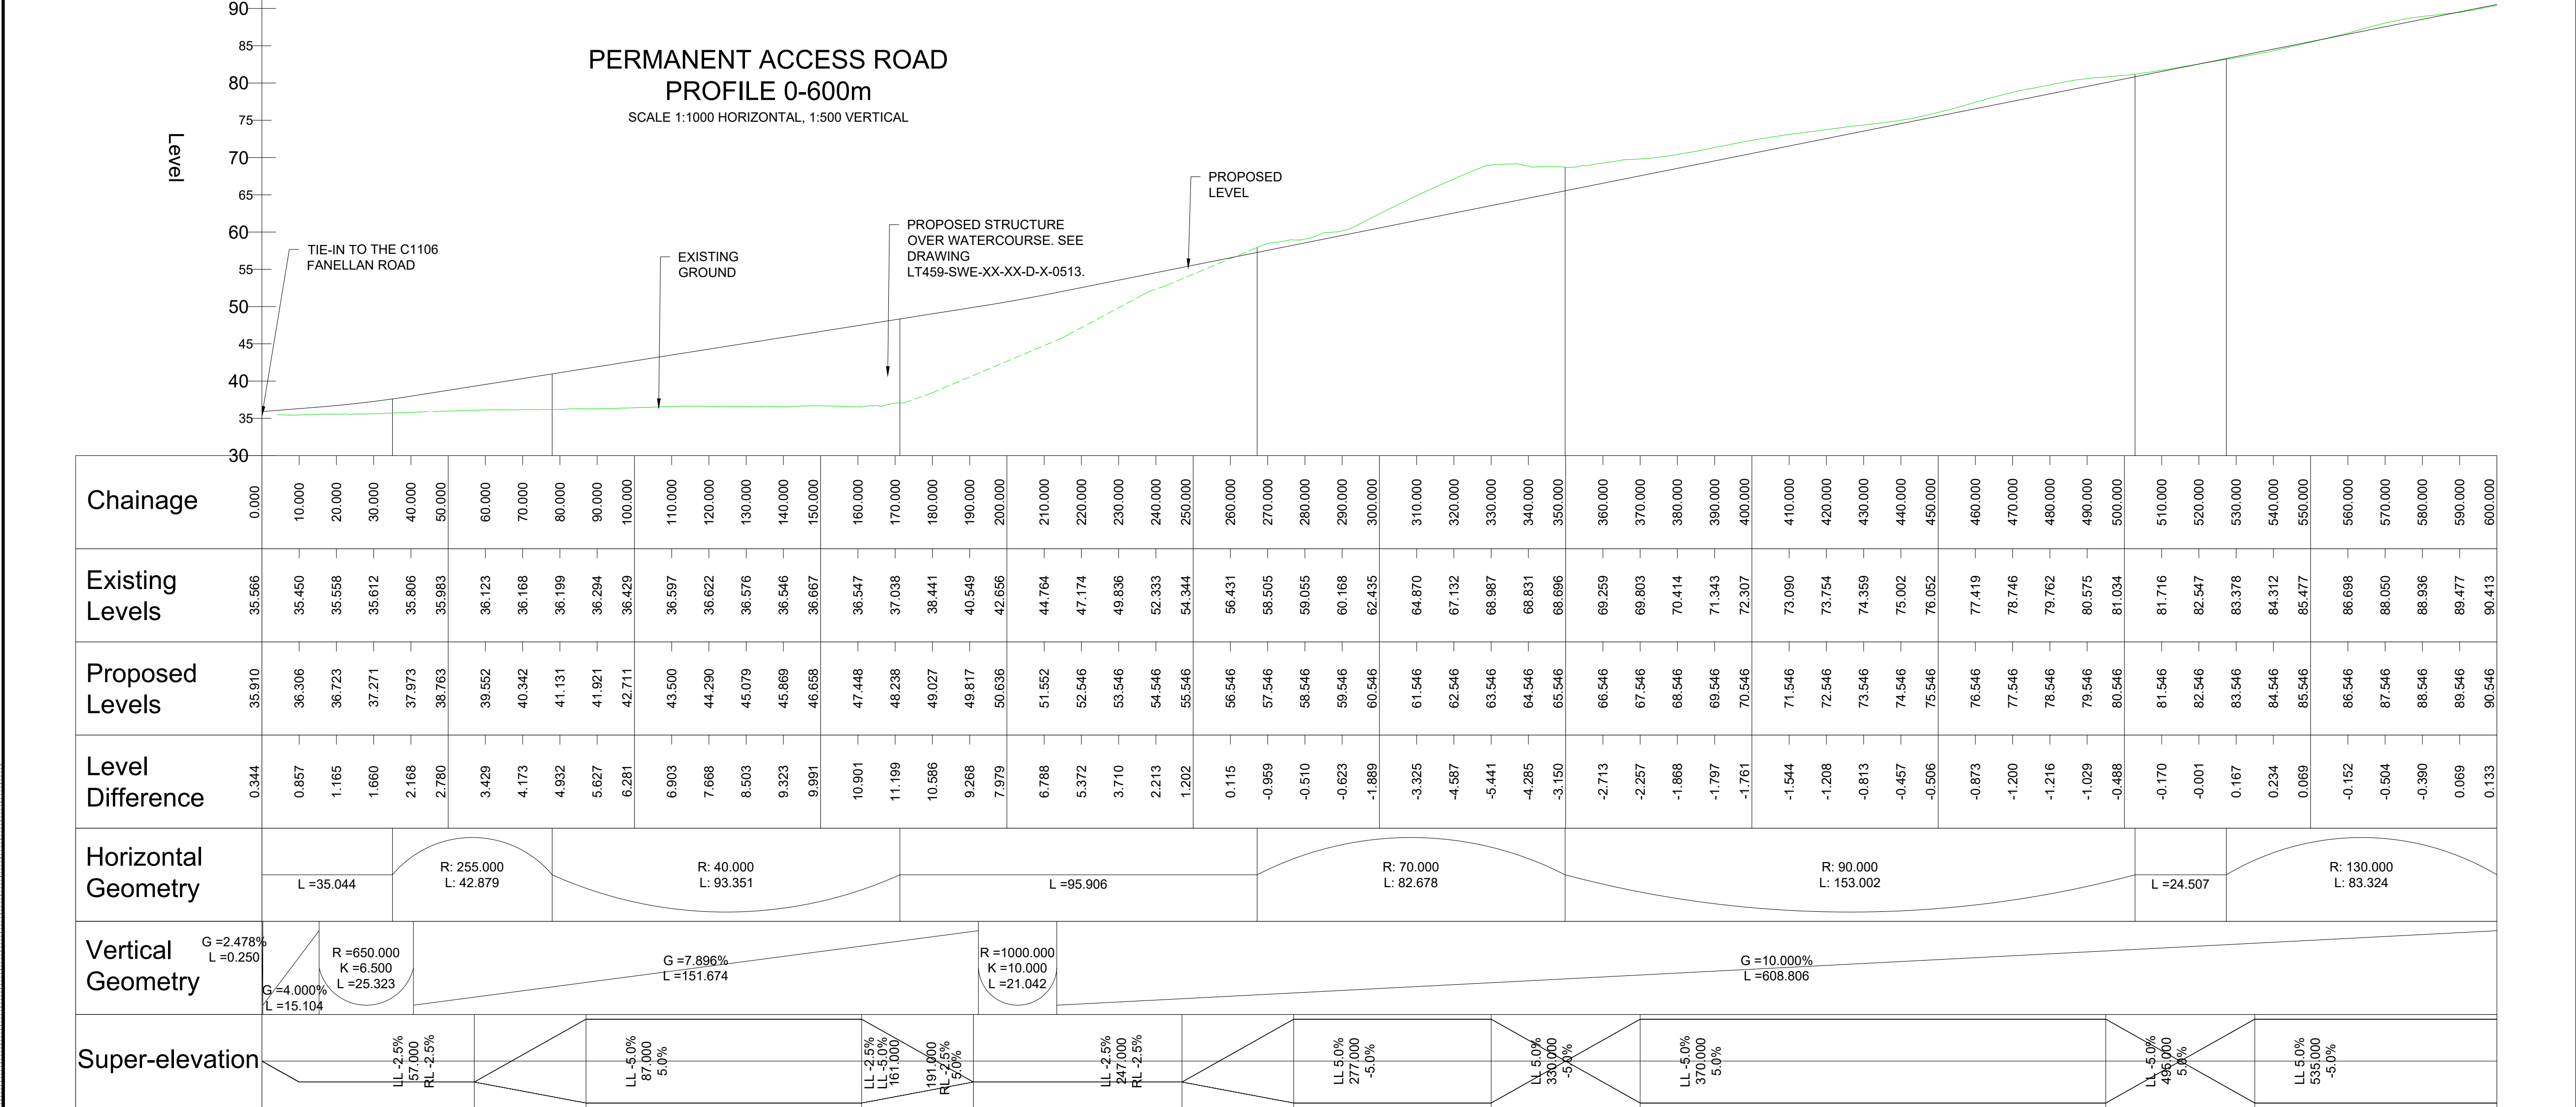


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NOTES

- DO NOT SCALE FROM THIS DRAWING MANUALLY OR ELECTRONICALLY.
- THIS DRAWING IS TO BE READ IN CONJUNCTION WITH ALL OTHER RELEVANT PROJECT INFORMATION.
- ALL DATUM LEVELS ARE IN METRES AND DIMENSIONS ARE IN METRES UNLESS OTHERWISE STATED.
- FOR DETAILS OF THE MAIN ACCESS ROAD JUNCTION TO THE BEAULY HUB SITE GENERAL LAYOUT, REFER TO DRAWING LT459-SWE-XX-XX-D-X-0103.

KEY TO DRAWING

- SITE BOUNDARY
- GEOMETRY CONTROL LINE
- PROPOSED ROAD CENTRELINE LEVELS
- EXISTING GROUND LEVELS

P07	27/02/2025	FOR PLANNING	NG	RL	CB
P06	24/01/2024	VERTICAL GEOMETRY UPDATED	NG	RL	CB
P05	20/08/2024	FINAL LAYOUT	NG	RL	CB
P04	14/06/2024	LAYOUT UPDATED	NG	RL	CB
P03	18/04/2024	DESIGN FIX 2C	NG	RL	CB
P02	08/03/2024	DESIGN FIX 2B	NG	RL	CB
P01	15/12/2023	DESIGN FIX A	MA	RL	CB
Rev	Date	Amendment Details	Dr'n	Chk'	App'

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SWECO

Client

TRANSMISSION

Project Title
**BEAULY HUB
400kV SWITCHING STATION AND
HVDC CONVERTOR STATION**

Drawing Title
**PERMANENT ACCESS ROAD
PLAN AND PROFILE
SHEET 1 OF 3**

Purpose Of Issue
PRELIMINARY

Status
S5 Status Description
FOR REVIEW AND ACCEPTANCE

Drawn NG	Designed NG	Checked RL	Approved CB
Sheet Size A1	Scale AS SHOWN	Sweco Ref 65209842	Revision P07

Drawing Number
LT459-SWE-XX-XX-D-X-0104